[illegible]

ETERNAL EARTH TECHNOLOGIES INC

1520 SHAWNIGAN-MILL BAY ROAD SHAWNIGAN LAKE, BC V0R 2W2

Project Title:

Sheet Title:

Scale: as shown	Drawn By: CB
	Date: Aug. 20, 2015

Drawing Number:

1



1/4" = 1'-0"

AREA = 73.9 SQ.M (795 SQ.FT)




1/4" = 1'-0"

AREA = 38.5 SQ.M (415 SQ.FT)



1/4" = 1'-0"

AREA = 82.1 SQ.M (885 SQ.FT)

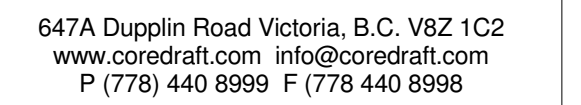[illegible]

ETERNAL EARTH TECHNOLOGIES INC
1520 SHAWNIGAN-MILL BAY ROAD SHAWNIGAN LAKE, BC V0R 2W2

Project Title:

Sheet Title:



EXTERIOR ELEVATIONS


Scale:
as shown

Drawn By:	CB
Date:	Aug. 20, 2015

Drawing Number:

3

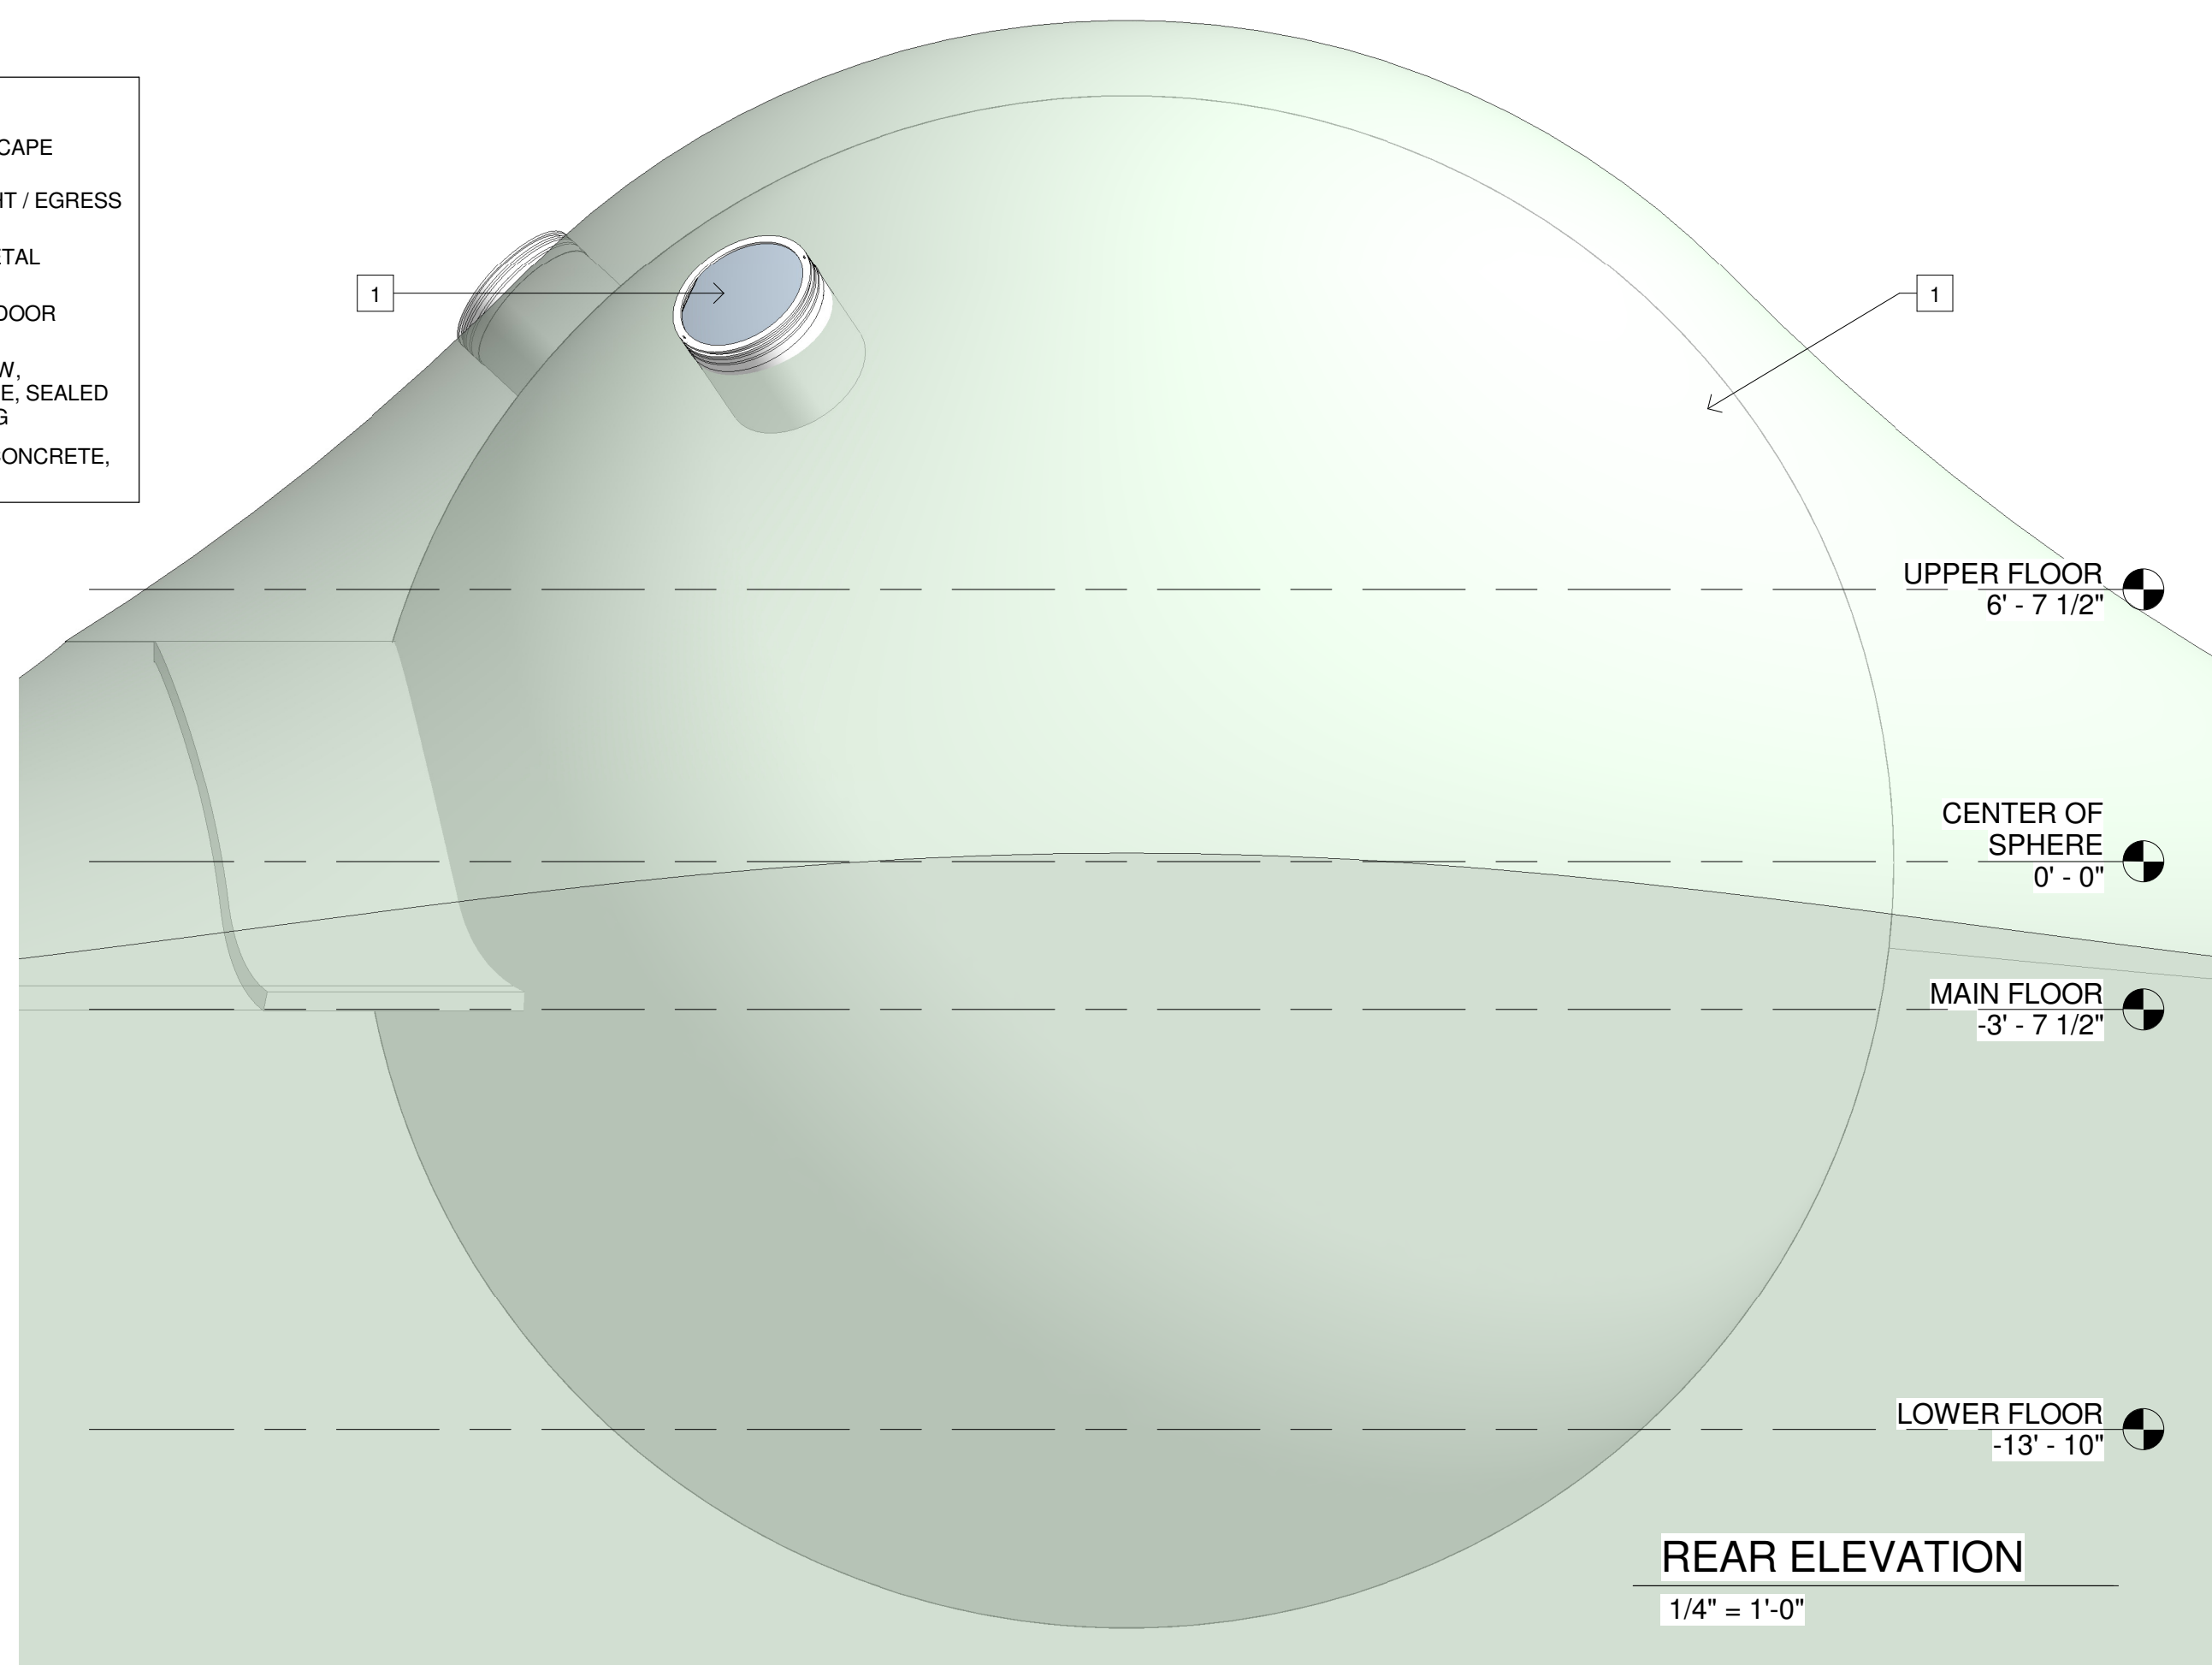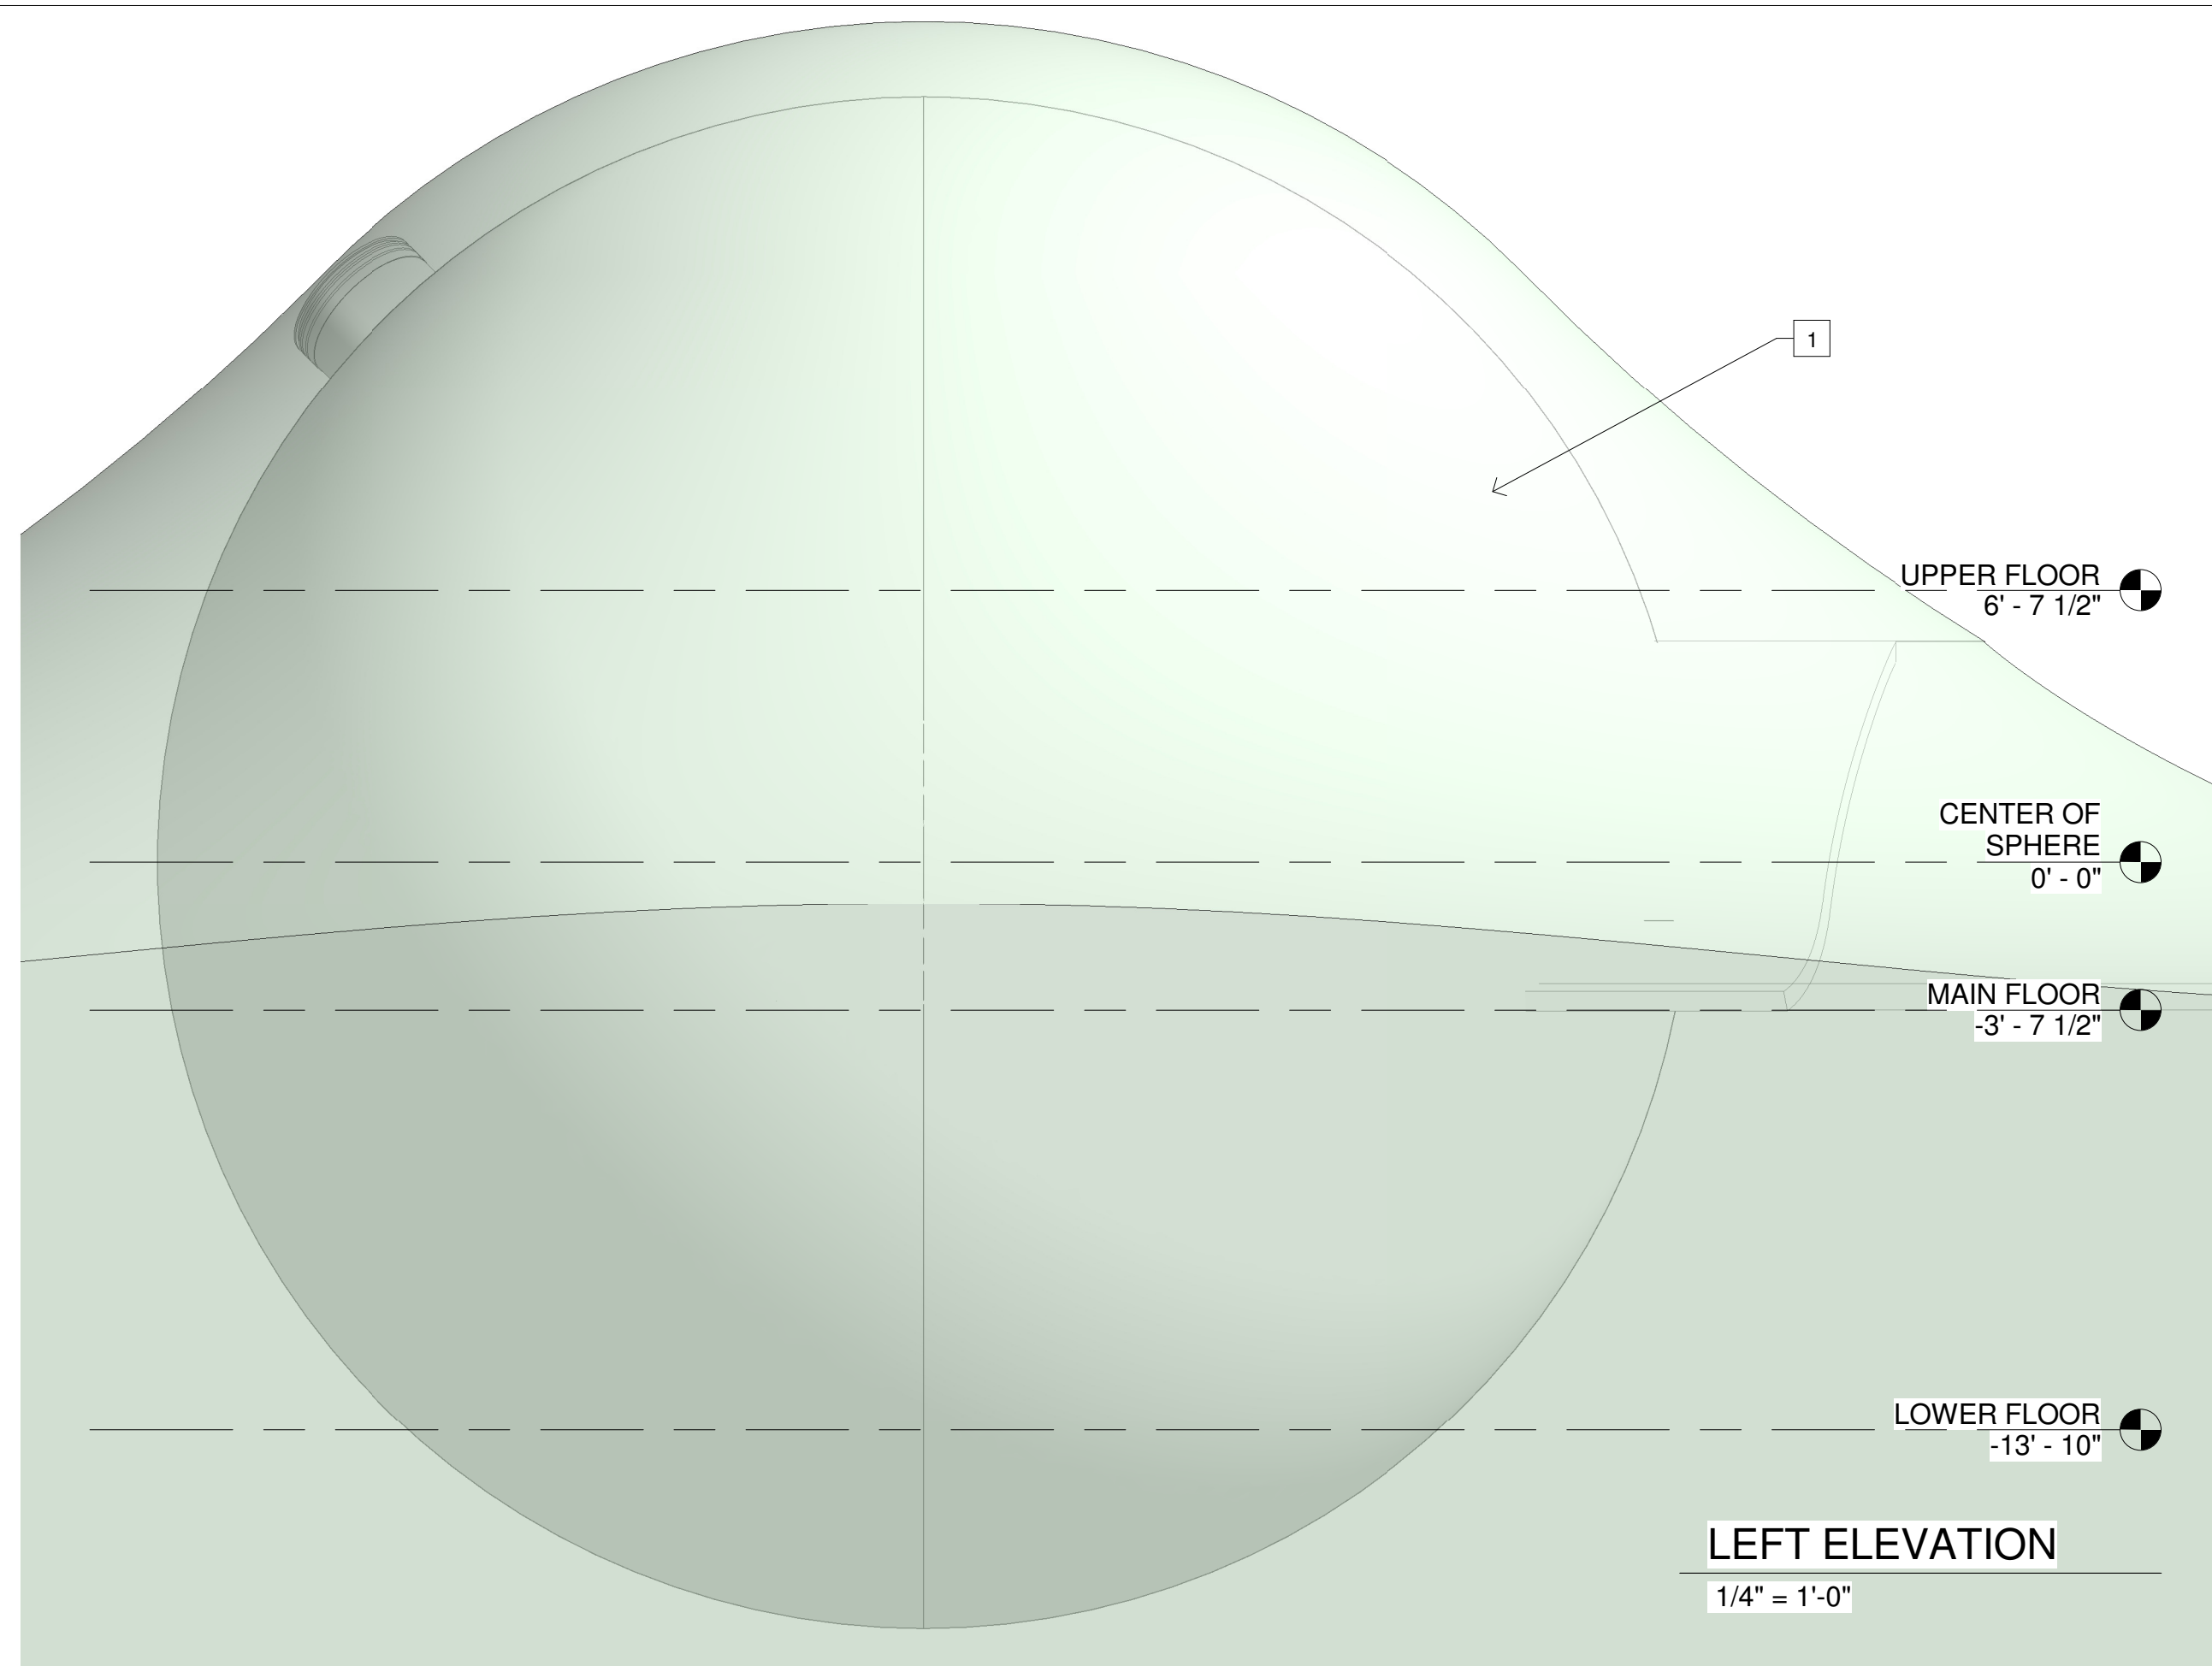

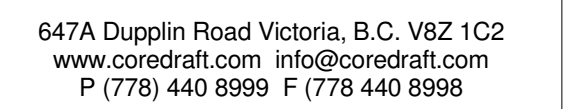[illegible]

ETERNAL EARTH TECHNOLOGIES INC
1520 SHAWNIGAN-MILL BAY ROAD SHAWNIGAN LAKE, BC V0R 2W2

Project Title:

Sheet Title:

BUILDING SECTIONS

Scale:
as shown

Drawn By:	CB
Date:	Aug. 20, 2015

Drawing Number:

4


$$1/4'' = 1'-0''$$

<h2 style="text-align: center; margin: 0;">TYPICAL BELOW GRADE ASSEMBLIES</h2> <h3 style="text-align: center; margin: 0;">(CLIMATE ZONE 5)</h3>		
W1 EXTERIOR WALL	4" INTERIOR AIR FILM 2 x 14" DRYWALL 4" POLYISOCYANURATE INSULATION, 8" CONCRETE, REINFORCED, CAST-IN-PLACE, WITH WATERPROOFING ADDITIVE DAMPPROOFING DRAINAGE LAYER COMPACTED GRANULAR FILL UNDISTURBED EARTH TOTAL RSteff (K ^{m2} /W) [min. allowable 4.20] =	0.12 0.08 4.00 0 0 0 0 0 0 4.20
F1 FLOOR OVER UNHEATED SPACE	TOTAL RSteff (K ^{m2} /W) [min. allowable 4.90] =	0
R1 CATHEDRAL ROOF	TOTAL RSteff (K ^{m2} /W) [min. allowable 4.90] =	0

<h2 style="text-align: center; margin: 0;">TYPICAL UNHEATED ASSEMBLIES</h2>	
<p>W2 TYPICAL INTERIOR WALL</p>	<p>1/2" DRYWALL, 2"x4" WOOD STUDS @ 16" O.C., 1/2" DRYWALL</p>
<p>W3 TYPICAL PLUMBING WALL</p>	<p>1/2" DRYWALL, 2"x6" WOOD STUDS @ 16" O.C., 1/2" DRYWALL *NOTE: USE WATER-RESISTANT DRYWALL IN WASHROOM AREAS.</p>
<p>F2 TYPICAL INTERIOR FLOOR</p>	<p>5/8" T&G PLYWOOD SHEATHING 11 7/8" TJI JOISTS @ 16" O.C. W/ X-BRIDGING 5/8" DRYWALL</p>